


CSH6A

TO NEXT TGB RE: T3.1-2 PROVIDE BOND TO INDICATED ITEMS CONNECTORS ARE 2-HOLE COMPRESSION TYPE BBC-X
3/0,cu #6AWG → BUSBAR ON EQUIPMENT RACK #6AWG — EQUIPMENT GROUNDS — SECURITY PANELS #6AWG — BUILDING STEEL #6AWG — CABLE TRAY FOR COMMUNICATION CABLES #6AWG — COMMUNICATIONS POWER PANELBOARD #6AWG — COMMUNICATIONS CABLE SHIELDS #6AWG — METAL CONDUIT ENDS #6AWG — PATIENT BED GROUNDING LUG #6AWG #6AWG #10AWG NETWORK EQUIPMENT GROUND LUG RACK MOUNTED BUSBAR TYPICAL IDF BUSBAR **TELECOMMUNICATIONS** MAIN GROUNDING BUSBAR AT PBX ROOM G02B

# TELECOMMUNICATION GROUNDING SCHEMATIC

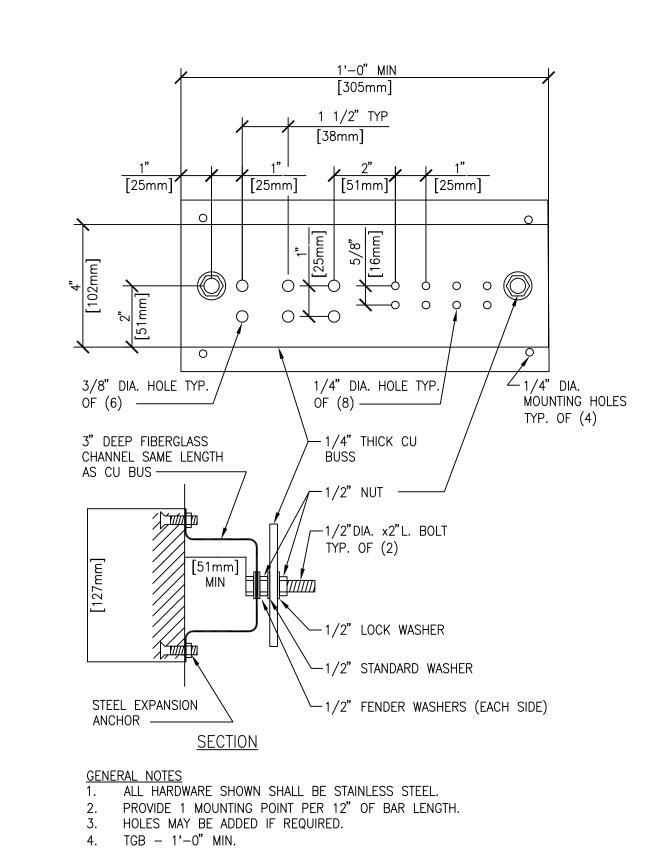

GROUNDING BAR DETAIL (TGB) SCALE: NONE

5. TMGB - 20" MIN.

#### GENERAL NOTES:

- A. J-HOOKS NOT SHOWN. PROVIDE J-HOOKS ABOVE ACCESSIBLE LAY-IN TILE CEILING AT 48" SPACING.
- INSTALL ALL COMMUNICATION CABLES IN CABLE TRAY UNLESS
- OTHERWISE NOTED. C. TERMINATE CAT 6 UTP CABLES PER T568A PINNING.
- BOND METALLIC MATERIALS TOGETHER TO INCLUDE CONDUIT SLEEVES. FASTEN CONDUIT ENDS TO CABLE TRAY WITH MANUFACTURER'S FITTINGS OR BOND TO TRAY WITH #6 GREEN INSULATED BONDING CONDUCTOR. BOND DISJOINTED TRAY SECTIONS
- LABEL CABLE ENDS, FACEPLATES AND JACKS WITH PRE-APPROVED LABELING PRODUCTS TO MATCH APPROVED LABEL SAMPLES.
- FIRESTOP WALL AND FLOOR PENETRATIONS PER APPROVED UL SYSTEMS. RETURN GYPSUM BOARD AND ACOUSTICAL TILE
- PENETRATION TO ORIGINAL FIRE RATING.
- COORDINATE WITH OWNER AND PROVIDE CONNECTIVITY TO EXISTING SYSTEMS IN OTHER BUILDINGS AS FOLLOWS: FIRE ALARM SYSTEM - BUILDING 50 REFRIGERATION MONITORING - BUILDING 114, 50 AND 46. ACCESS CONTROL - BUILDING 67.
- H. INSTALL SECURITY CABLES IN CONDUIT UNLESS OTHERWISE NOTED.
- WORK OF DIVISIONS 26, 27 AND 28 IS SHOWN ON THIS DRAWING.

#### # SHEET NOTES:

- . NETWORK EQUIPMENT PROVIDED BY OWNER.
- 2. PROVIDE CONNECTIVITY AS REQUIRED TO ENABLE REMOTE MONITORING PER GENERAL NOTE G ON THIS SHEET.
- 3. PROVIDE 2-HOLE LUGS ON EXISTING BONDING CONDUCTORS AND TRANSFER TO NEW BUSBAR RE: GENERAL NOTE G AND T3.1-3.
- 4. PROVIDE NEW BUSBARS ON WALL. RE: T3.1-3.
- 5. PROVIDE NEW BONDING CONDUCTOR THROUGH EXISTING PATHWAY AND BOND TO EACH NEW BUSBARS WITH 2-HOLE LUGS.
- 6. REPLACE EXISTING TMGB WITH NEW BUSBAR. RE: T2.0-1.
- 7. VERIFY AND DOCUMENT EXISTING BONDING CONDUCTORS.

PROJECT TITLE BOISE VAMC TELECOMMUNICATIONS BUILDING 67 EXPANSION PROJECT NO. 531-320 APPROVED: CHIEF OF FACILITY MANAGEMENT SERVICE BUILDING NUMBER CHECKED DRAWING NO. AKD JDR APPROVED: MEDICAL CENTER DIRECTOR VAMC BOISE, IDAHO DEPARTMENT OF VETERANS AFFAIRS DWG 174 OF 191

C.W. MOORE PLAZA 250 S. 5TH ST. BOISE, ID 83702 (208) 343-4635 FAX (208) 343-1858


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531-320\_T3.1.DWG XREF FILE NAME: 531-320\_30X42TLBK.DWG

CAD FILE NAME:

SCHEMATICS



#### GENERAL NOTES:

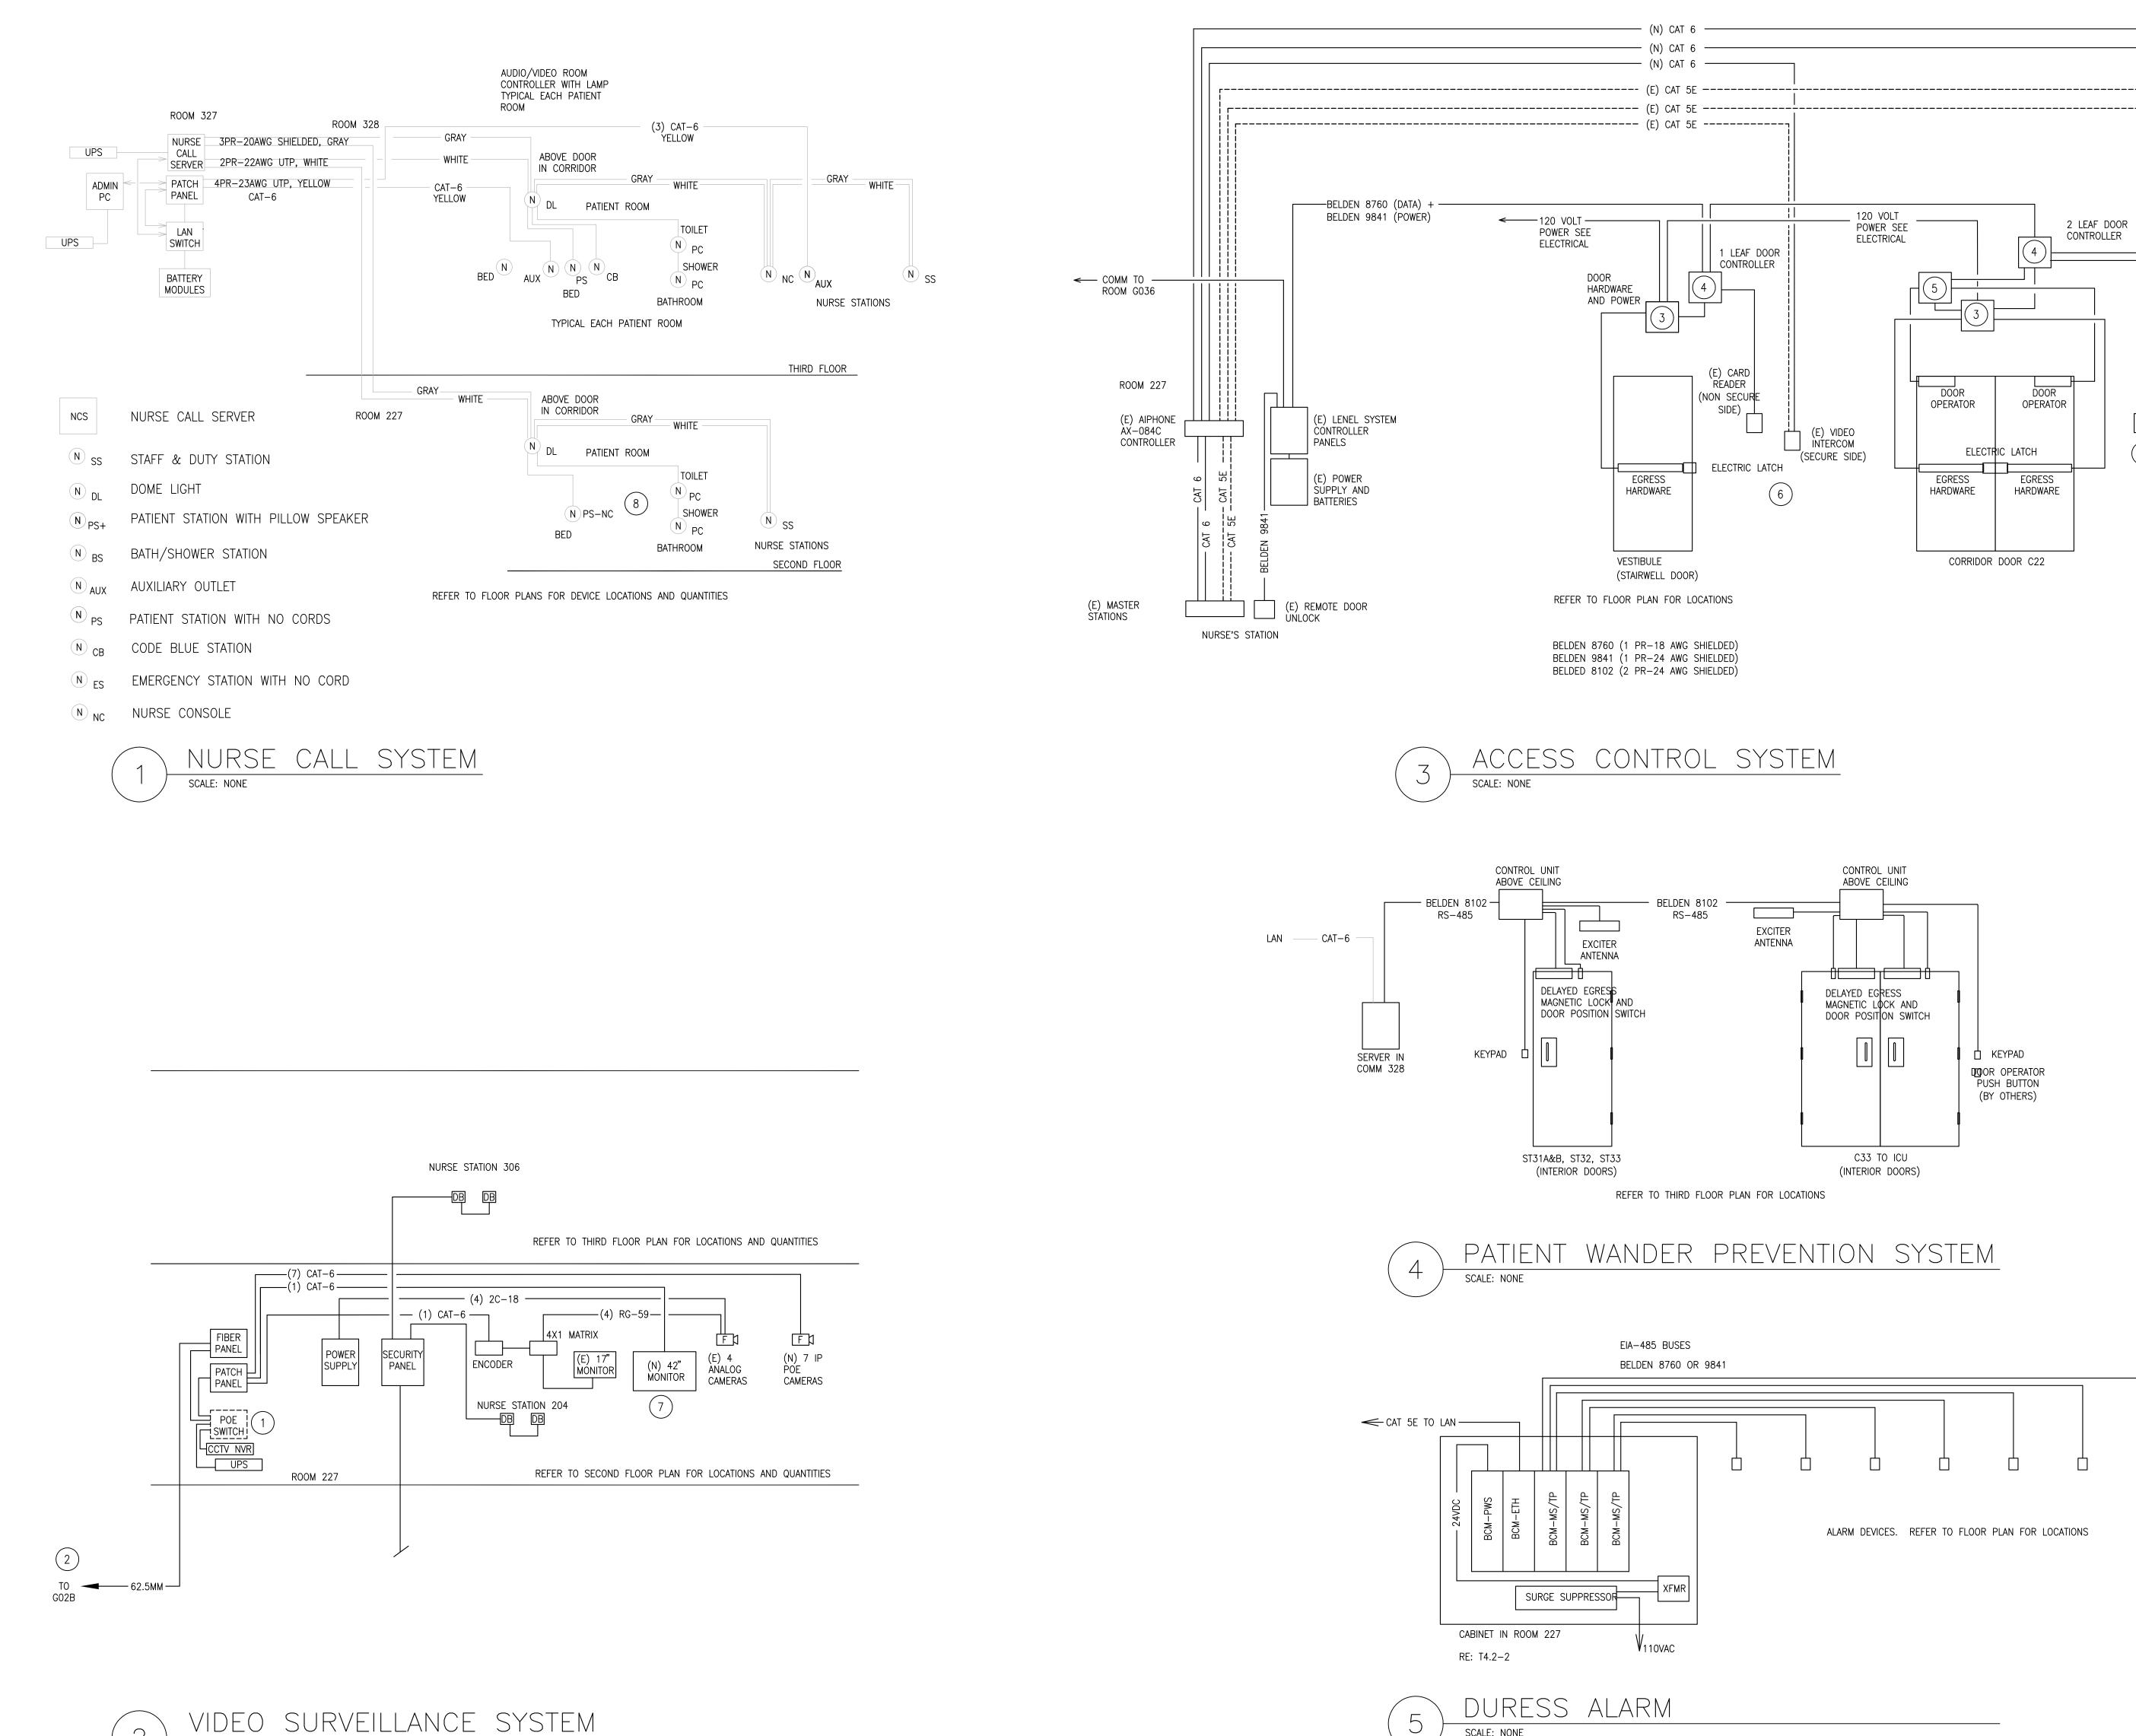- A. J-HOOKS NOT SHOWN. PROVIDE J-HOOKS ABOVE ACCESSIBLE
- LAY-IN TILE CEILING AT 48" SPACING. INSTALL ALL COMMUNICATION CABLES IN CABLE TRAY UNLESS
- OTHERWISE NOTED. TERMINATE CAT 6 UTP CABLES PER T568A PINNING.
- BOND METALLIC MATERIALS TOGETHER TO INCLUDE CONDUIT SLEEVES. FASTEN CONDUIT ENDS TO CABLE TRAY WITH MANUFACTURER'S FITTINGS OR BOND TO TRAY WITH #6 GREEN INSULATED BONDING CONDUCTOR. BOND DISJOINTED" TRAY SECTIONS
- LABEL CABLE ENDS, FACEPLATES AND JACKS WITH PRE-APPROVED LABELING PRODUCTS TO MATCH APPROVED LABEL SAMPLES.
- FIRESTOP WALL AND FLOOR PENETRATIONS PER APPROVED UL SYSTEMS. RETURN GYPSUM BOARD AND ACOUSTICAL TILE PENETRATION TO ORIGINAL FIRE RATING.
- COORDINATE WITH OWNER AND PROVIDE CONNECTIVITY TO EXISTING SYSTEMS IN OTHER BUILDINGS AS FOLLOWS: FIRE ALARM SYSTEM - BUILDING 50 REFRIGERATION MONITORING - BUILDING 114, 50 AND 46. SECURITY — BUILDING 67.
- H. INSTALL SECURITY CABLES IN CONDUIT UNLESS OTHERWISE NOTED. WORK OF DIVISIONS 26, 27 AND 28 IS SHOWN ON THIS DRAWING.

#### # SHEET NOTES:

(E) VIDEO INTERCOM

(E) VIDEO

INTERCOM

(SECURE SIDE)

(E) CARD

`RÉADER (SECURE SIDE)

(NON-SECURE SIDE

(E) CARD

READER

SIDE)

☐ (NON-SECURE


- EXISTING NETWORK EQUIPMENT. PROVIDE CONNECTIVITY AS NEEDED TO ENABLE REMOTE MONITORING
- PER GENERAL NOTE G ON THIS SHEET. PROVIDE JUNCTION BOX FOR LOW VOLTAGE ELECTRIFIED DOOR

SECURITY AT NEW DOOR LOCATIONS. REUSE EXISTING MATERIALS

- PROVIDE JUNCTION BOX FOR SECURITY DEVICE WIRING.
- PROVIDE JUNCTION BOX DOOR OPERATOR WIRING.
- REPLACE ACCESS CONTROL CABLING AS NEEDED TO REACTIVATE

AS POSSIBLE. PROVIDE NEW CABLE.

- VIEW 11 CAMERAS ON NEW MONITOR, INSTALL OWNER FURNISHED
- MONITOR AND MOUNT. PROVIDE CABLING AND ADAPTERS FOR CAT-6 CABLING AS NEEDED.
- DEVICES ON SECOND FLOOR SHALL NOT HAVE CORDS.

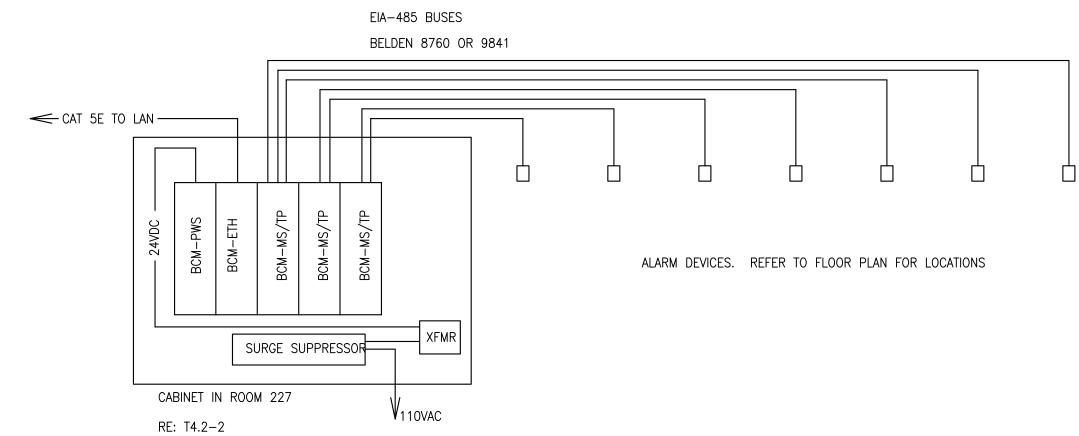

SCALE: NONE

PROJECT NO. 531-320 DRAWING NO. DEPARTMENT OF VETERANS AFFAIRS

AMY K. DOCKTER, P.E. C.W. MOORE PLAZA 250 S. 5TH ST BOISE, IDAHO PHONE: 208-343-4635 FAX: 208-343-1858 THESE DRAWINGS AND SPECIFICATIONS, AS INSTRUMENTS OF SERVICE, ARE AND SHALL REMAIN THE PROPERTY OF THE ARCHITECT / ENGINEER WHETHER THE PROJECT FOR O. 7-12-13 P C.W. MOORE PLAZA WHICH THEY ARE MADE IS EXECUTED OR NOT. THESE DRAWINGS AND SPECIFICATIONS SHALL NOT BE USED BY 250 S. 5TH ST. BOISE, ID 83702 ANY PERSON OR ENTITY ON OTHER PROJECTS, FOR ADDITIONS TO THIS PROJECT, OR COMPLETION OF THIS (208) 343-4635 FAX (208) 343-1858 PROJECT-WHEN PHASED-WITHOUT THE WRITTEN CONSENT OF CSHQA OR ITS AFFILIATES. Copyright ●2013 http://www.cshqa.com

SCALE: NONE


CSH6A





DRAWING TITLE CAD FILE NAME: 531-320\_T3.2.DWG XREF FILE NAME: 531-320\_30X42TLBK.DWG

PROJECT TITLE
BOISE VAMC SECURITY BUILDING 67 EXPANSION SCHEMATICS BUILDING NUMBER APPROVED: CHIEF OF FACILITY MANAGEMENT SERVICE CHECKED AKD APPROVED: MEDICAL CENTER DIRECTOR

JDR VAMC BOISE, IDAHO

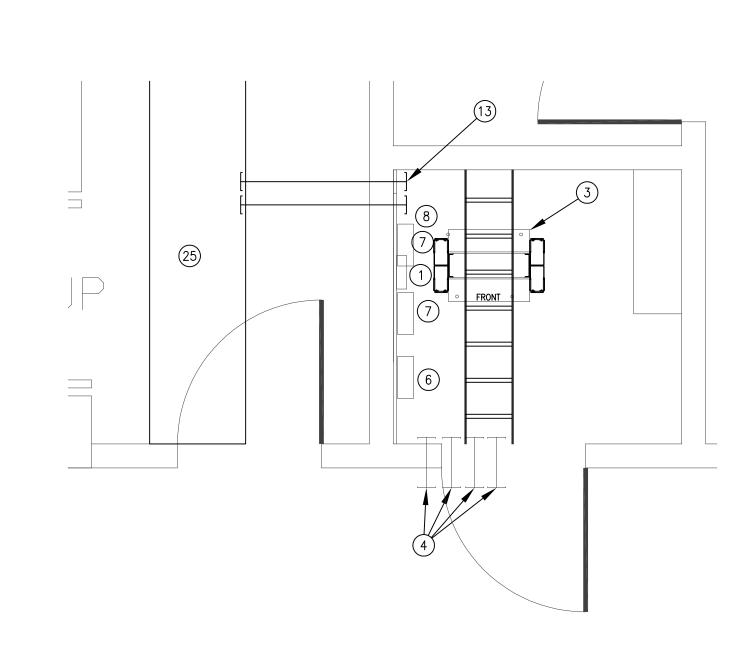


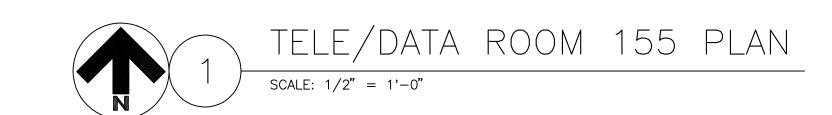

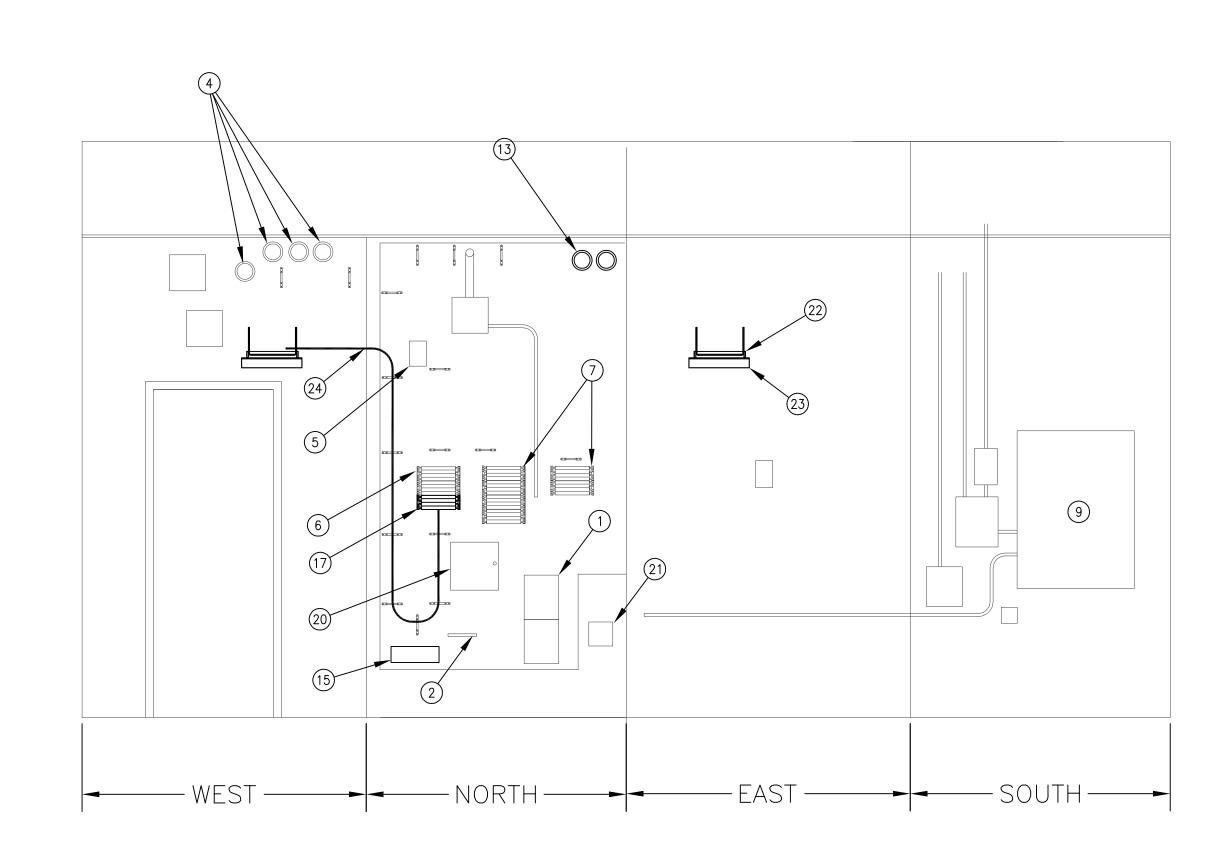


ROOM 155 WALL ELEVATIONS

CSH6A

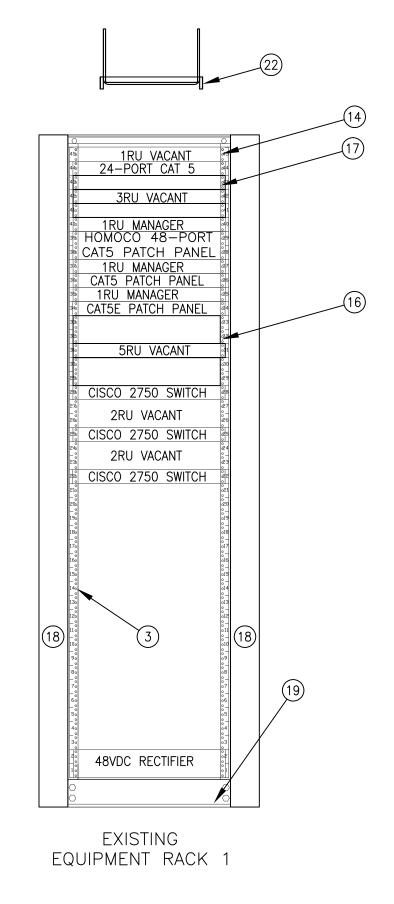


ROOM 155 RACK ELEVATION


SCALE: 1" = 1'-0"

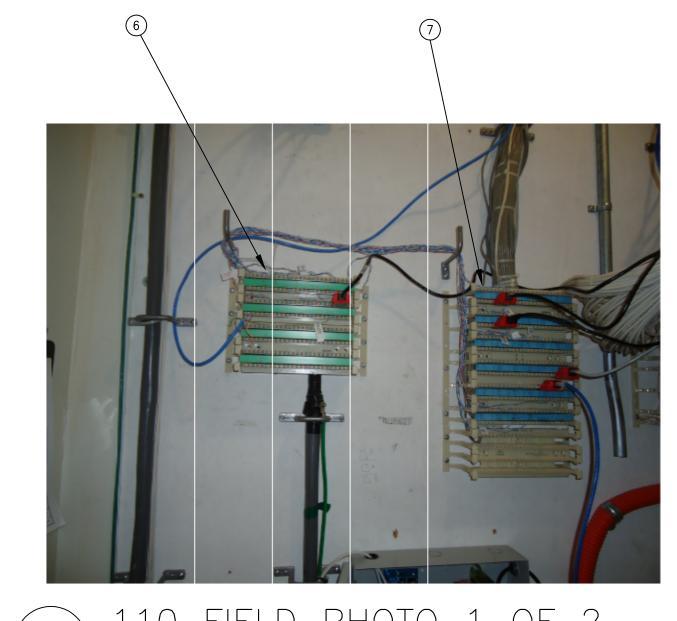

110 FIELD PHOTO 1 OF 2 SCALE: NONE

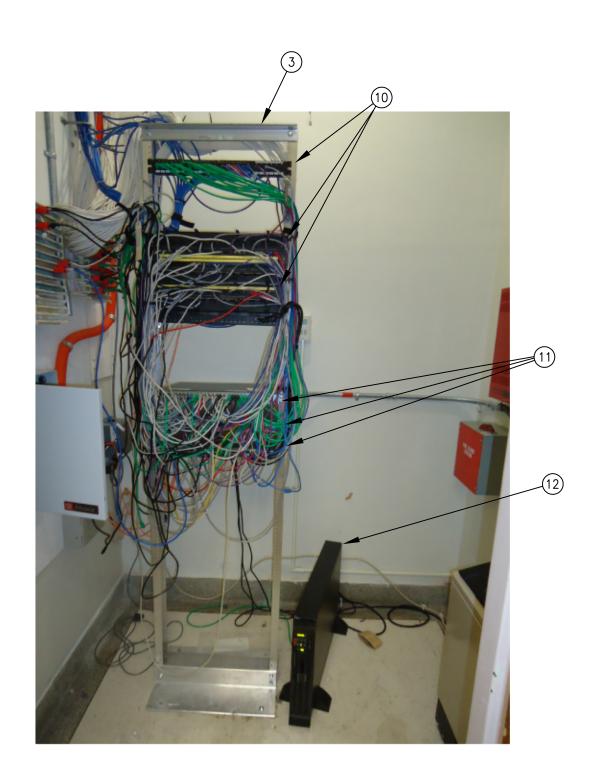

EQUIPMENT RACK PHOTO SCALE: NONE

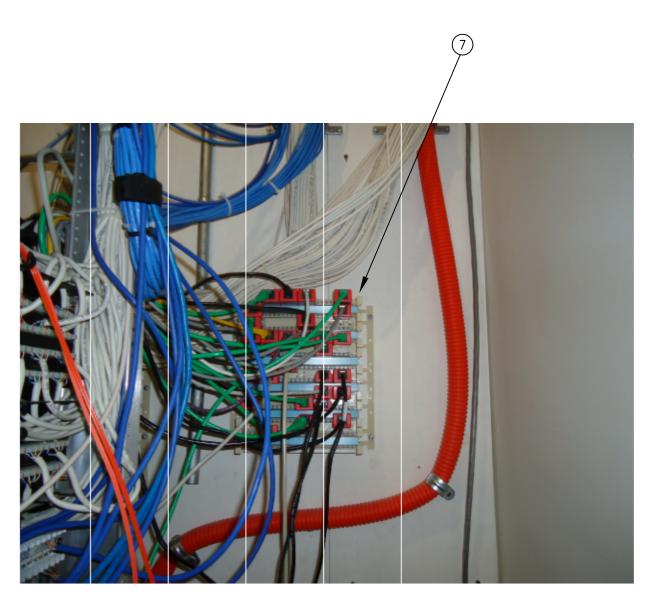

110 FIELD PHOTO 2 OF 2

## GENERAL NOTES:

- A. TERMINATE CABLES FROM FIRST FLOOR IN THIS TELECOMMUNICATIONS ROOM.
- B. FIRESTOP WALL PENETRATIONS AND CONDUIT SLEEVE ENDS AFTER INSTALLATION OF CABLES.
- C. COORDINATE WITH ARCHITECTURAL, MECHANICAL, ELECTRICAL, AND FIRE SAFETY WORK TO AVOID CONFLICTS. DO NOT BEGIN INSTALLATION OF TELECOMMUNICATIONS HARDWARE UNTIL DOOR IS INSTALLED AND SPACE IS PAINTED.
- D. REFER TO SHEET T3.1-3 FOR BONDING AND GROUNDING REQUIREMENTS OF TMGB AND TGB.

#### # SHEET NOTES:

- 1. (E) WALL MOUNTED OPTICAL FIBER ENCLOSURES.
- 2. (E) GROUNDING BUS. REPLACE WITH NEW PER SHEET NOTE 15.
- 3. (E) EQUIPMENT RACK.
- 4. (E) CONDUIT SLEEVES WITH FIRESTOPPING PUTTY.
- 5. (E) CATV TAP
- 6. (E) CAT-3 BACKBONE TERMINATION ON 110 BLOCKS, 901-1100. 7. (E) CAT-5 HORIZONTAL TERMINATIONS ON 110 BLOCKS.
- 8. (E) WALL-MOUNTED SECURITY PANEL.
- 9. (E) FIRE ALARM PANEL. 10. (E) PATCH PANELS.
- 11. (E) NETWORK SWITCHES.
- 12. (E) NETWORK UPS.
- 13. (N) SLEEVES WITH FIRESTOP TO CABLE TRAY IN CORRIDOR.
- 14. (N) RACK MOUNT GROUND BAR WITH NO. 6 CONDUCTOR TO NEW WALL MOUNT BUSBAR.
- 15. (N) WALL MOUNT BUSBAR WITH 3/O BONDING CONDUCTOR TO TMGB. TRANSFER EXISTING CONDUCTORS FROM EXISTING BAR.
- 16. (N) PATCH PANELS AND 1 RU HORIZONTAL MANAGERS WITH COVERS
- FOR NEW HORIZONTAL CABLING.
- 17. (N) PATCH PANEL WITH 25—PAIR TIE CABLE FROM TWISTED PAIR BACKBONE TERMINATIONS ON 110 BLOCKS. 18. PROVIDE TWO DOUBLE SIDED VERTICAL CABLE MANAGERS (CPI
- 13911-703 OR EQUAL), 3.9"(100MM)W X 16.4" (400MM) D X 7'H. DRESS EXISTING AND NEW HORIZONTAL CABLE IN BACK AND PATCH CORDS IN FRONT. 19. MOVE EXISTING EQUIPMENT RACK TO ALLOW INSTALLATION OF
- VERTICAL MANAGERS AND PROVIDE NEW ANCHORS IN CONCRETE FLOOR. PLUG ABANDONED ANCHOR HOLES. DRESS EXISTING CABLES ON REAR OF VERTICAL MANAGERS. DRESS EXISTING PATCH CORDS ON FRONT OF VERTICAL MANAGERS. INFORM OWNER OF EXISTING PATCH CORDS THAT MUST BE REPLACED DUE TO INSUFFICIENT LENGTH.
- 20. (E) POWER SUPPLY FOR SECURITY DEVICES.
- 21. (E) POWER SUPPLY AND INTERFACE ENCLOSURE FOR SECURITY
- 22. (N) 12" LADDER STYLE CABLE RACK AT7'-6" A.F.F.
- 23. (N) WALL ANGLE AND J-HOOKS AT WALL TO SUPPORT CABLE RACK. 24. (N) 25-PAIR, 24 AWG CAT 3 UTP FROM 110 WIRING BLOCK TO EQUIPMENT RACK. ROUTE ON NEW CABLE TRAY.
- 25. (N) TRAY IN CORRIDOR. BOND TO TGB.

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JAY ROMLEIN, RCDD

PHONE: 208-343-4635 FAX: 208-343-1858

C.W. MOORE PLAZA 250 S. 5TH ST

BOISE, IDAHO





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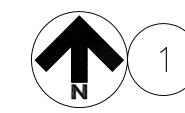
PROJECT TITLE
BOISE VAMC DRAWING TITLE FIRST FLOOR TELECOMMUNICATION ROOM DETAILS APPROVED: CHIEF OF FACILITY MANAGEMENT SERVICE BUILDING NUMBER

APPROVED: MEDICAL CENTER DIRECTOR


BUILDING 67 EXPANSION PROJECT NO. 531-320 CHECKED DRAWING NO. JDR JDR T4.1 VAMC BOISE, IDAHO



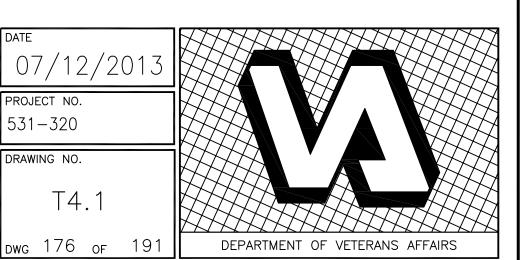


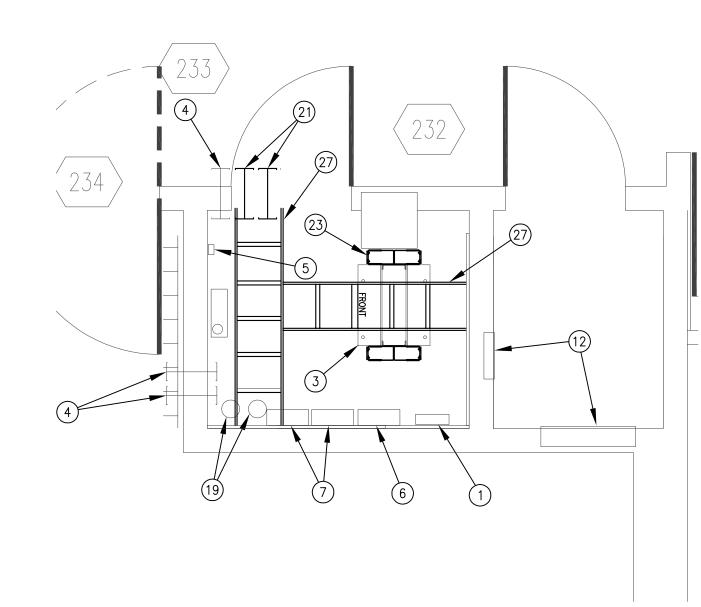


TELE/DATA ROOM 226 AND 227 PLAN

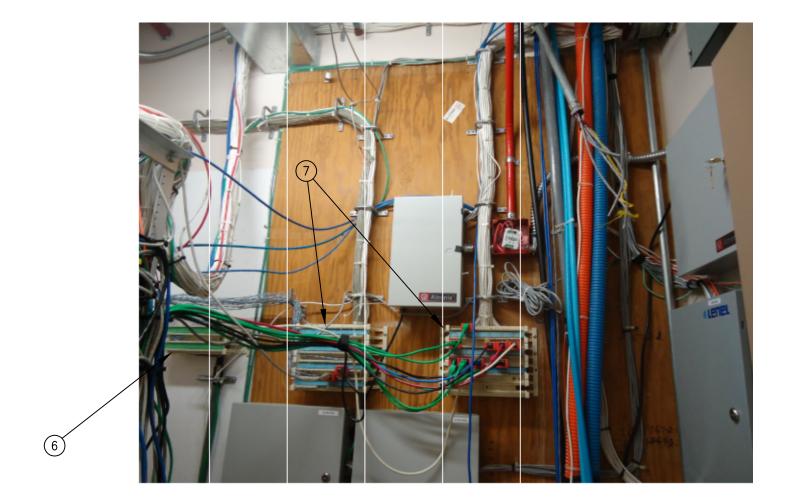

ROOM 227 110 FIELD PHOTO SCALE: 1/2" = 1'-0"

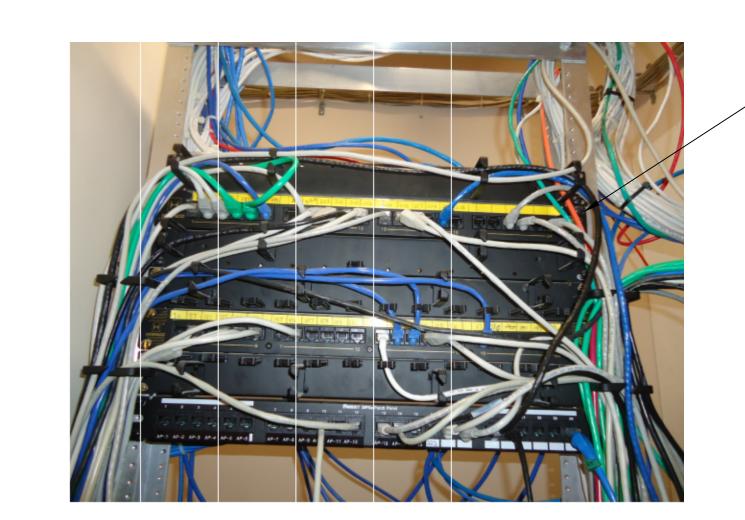


ROOM 227 PATCH PANEL PHOTO SCALE: 1/2" = 1'-0"

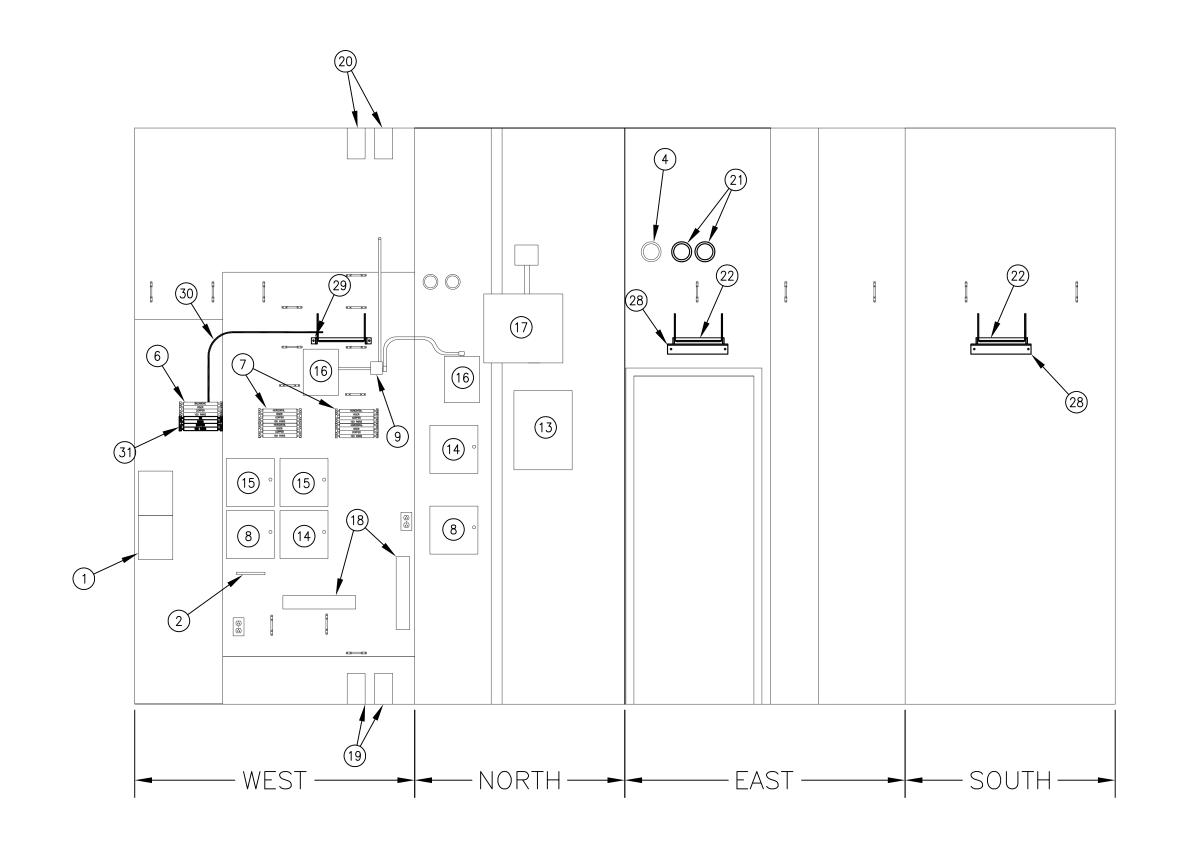

ROOM 227 WALL ELEVATIONS SCALE: 1/2" = 1'-0"



ROOM 226 WALL ELEVATIONS SCALE: 1/2" = 1'-0"

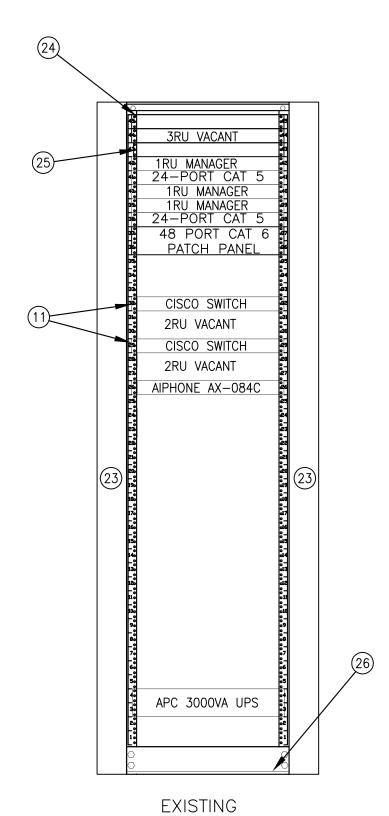

EQUIPMENT RACK 1

ROOM 227 RACK ELEVATION SCALE: 1" = 1'-0"



ROOM 226 PHOTO SCALE: NONE

### GENERAL NOTES:

- A. TERMINATE ALL CABLES FROM ALL FLOORS IN THIS TELECOMMUNICATIONS ROOM.
- B. FIRESTOP WALL PENETRATIONS AND CONDUIT SLEEVE ENDS AFTER INSTALLATION OF CABLES.
- C. COORDINATE WITH ARCHITECTURAL, MECHANICAL, ELECTRICAL, AND FIRE SAFETY WORK TO AVOID CONFLICTS. DO NOT BEGIN INSTALLATION OF TELECOMMUNICATIONS HARDWARE UNTIL DOOR IS INSTALLED AND SPACE IS PAINTED.
- D. REFER TO SHEET T3.1-3 FOR BONDING AND GROUNDING REQUIREMENTS OF TGB.

#### # SHEET NOTES:

- 1. (E) WALL MOUNTED OPTICAL FIBER ENCLOSURE.
- 2. (E) GROUNDING BUSBAR.
- 3. (E) EQUIPMENT RACK. SEE SHEET NOTE 26.
- 4. (E) CONDUIT SLEEVES WITH FIRESTOPPING PUTTY.
- 5. (E) CATV TAPS.
- 6. (E) CAT-3 BACKBONE TERMINATION ON 110 BLOCKS, 901-1100. PROVIDE BLOCK FOR TERMINATION OF 25-PAIR TIE CABLE TO RACK.
- 7. (E) CAT-5 HORIZONTAL TERMINATIONS ON 110 BLOCKS.
- 8. (E) LENEL DATA PANEL.
- 9. (E) FIRE ALARM JUNCTION BOX AND WITH WIRED DEVICE.
- 10. (E) PATCH PANELS.
- 11. (E) NETWORK SWITCHES.
- 12. ABANDONED NURSE CALL TO BE REMOVED.
- 13. DURESS ALARM PANEL. RE: T3.2-5.
- 14. (E) LENEL POWER SUPPLY PANEL.
- 15. (E) WATCHMATE POWER PANEL.
- 16. (E) ALTRONICS AL600 ULX POWER SUPPLY PANEL.
- 17. (E) JUNCTION BOX FOR DATA CABLING.
- 18. (E) PLUG STRIP.
- 19. (E) 2-4" CONDUIT SLEEVES TO FLOOR BELOW.
- 20. (E) 2-4" CONDUIT SLEEVES TO FLOOR ABOVE.
- 21. (N) 2-4" CONDUIT SLEEVES TO NEW CABLE TRAY IN CORRIDOR. 22. (N) 300mm (12") LADDER STYLE CABLE RACK.
- 23. PROVIDE TWO DOUBLE SIDED VERTICAL CABLE MANAGERS (CPI
- 13911-703 OR EQUAL), 3.9"W X 16.4"D X 7'H. DRESS EXISTING AND NEW HORIZONTAL CABLE IN BACK AND PATCH CORDS IN
- 24. (N) RACK MOUNTED GROUND BAR. RE: T3.1-3.
- 25. NEW PATCH PANEL WITH 25-PAIR TIE CABLE FROM TWISTED PAIR BACKBONE TERMINATIONS ON 110 BLOCKS.
- 26. MOVE EXISTING EQUIPMENT RACK TO ALLOW INSTALLATION OF VERTICAL MANAGERS AND PROVIDE NEW ANCHORS IN CONCRETE FLOOR. PLUG ABANDONED ANCHOR HOLES. REMOVE TOP ANGLES OF EQUIPMENT RACK TO PERMIT ROUTING OF CABLES TO REAR CHANNEL OF NEW VERTICAL CABLE MANAGERS. INFORM OWNER OF EXISTING PATCH CORDS THAT MUST BE REPLACED DUE TO INSUFFICIENT LENGTH.
- 27. (N) 12" LADDER STYLE CABLE RACK INSTALLED AT 7'-6" A.F.F.
- INSTALL NEW CABLES ON CABLE TRAY. 28. (N) WALL ANGLE SUPPORT KIT WITH J-HOOKS AT END OF CABLE TRAY ON WALL WHERE POSSIBLE.
- 29. (N) FOOT KIT WITH SPLICE PLATES ON RAILS TO SUPPORT CABLE TRÁY AND FIRE ENCLOSURE.
- 30. (N) 25-PAIR, 24 AWG CAT 3 UTP CABLE TO EQUIPMENT RACK. ROUTE OVER NEW CABLE TRAY.
- 31. (N) 110 WIRING BLOCK WITH LEGS. TERMINATE 25-PAIRS AND LABEL THE INSTALLATION.

JAY ROMLEIN, RCDD C.W. MOORE PLAZA 250 S. 5TH ST BOISE, IDAHO PHONE: 208-343-4635 FAX: 208-343-1858 THESE DRAWINGS AND SPECIFICATIONS, AS INSTRUMENTS

7.12.13 OF 10HER

CAD FILE NAME: 531-320\_T4.2.DWG XREF FILE NAME: 531-320\_30X42TLBK.DWG

SECOND FLOOR TELECOMMUNICATION ROOM DETAILS

APPROVED: CHIEF OF FACILITY MANAGEMENT SERVICE

APPROVED: MEDICAL CENTER DIRECTOR

PROJECT TITLE
BOISE VAMC BUILDING 67 EXPANSION

CHECKED

VAMC BOISE, IDAHO

JDR

BUILDING NUMBER

PROJECT NO. 531-320 DRAWING NO.

DWG 177 OF 191


JDR


DEPARTMENT OF VETERANS AFFAIRS


CSH6A

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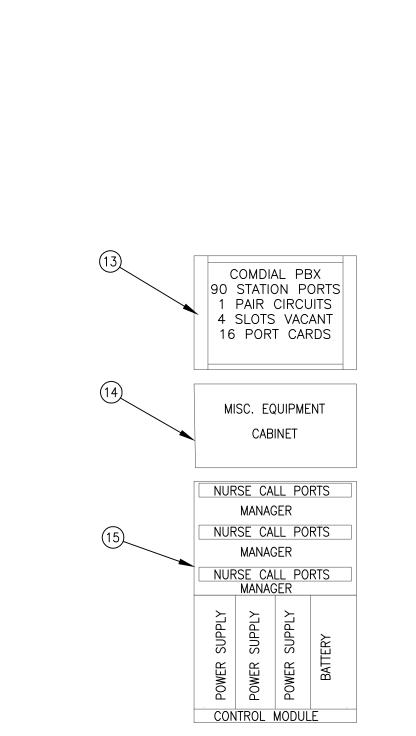
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(N) GROUND BAR

5RU VACANT

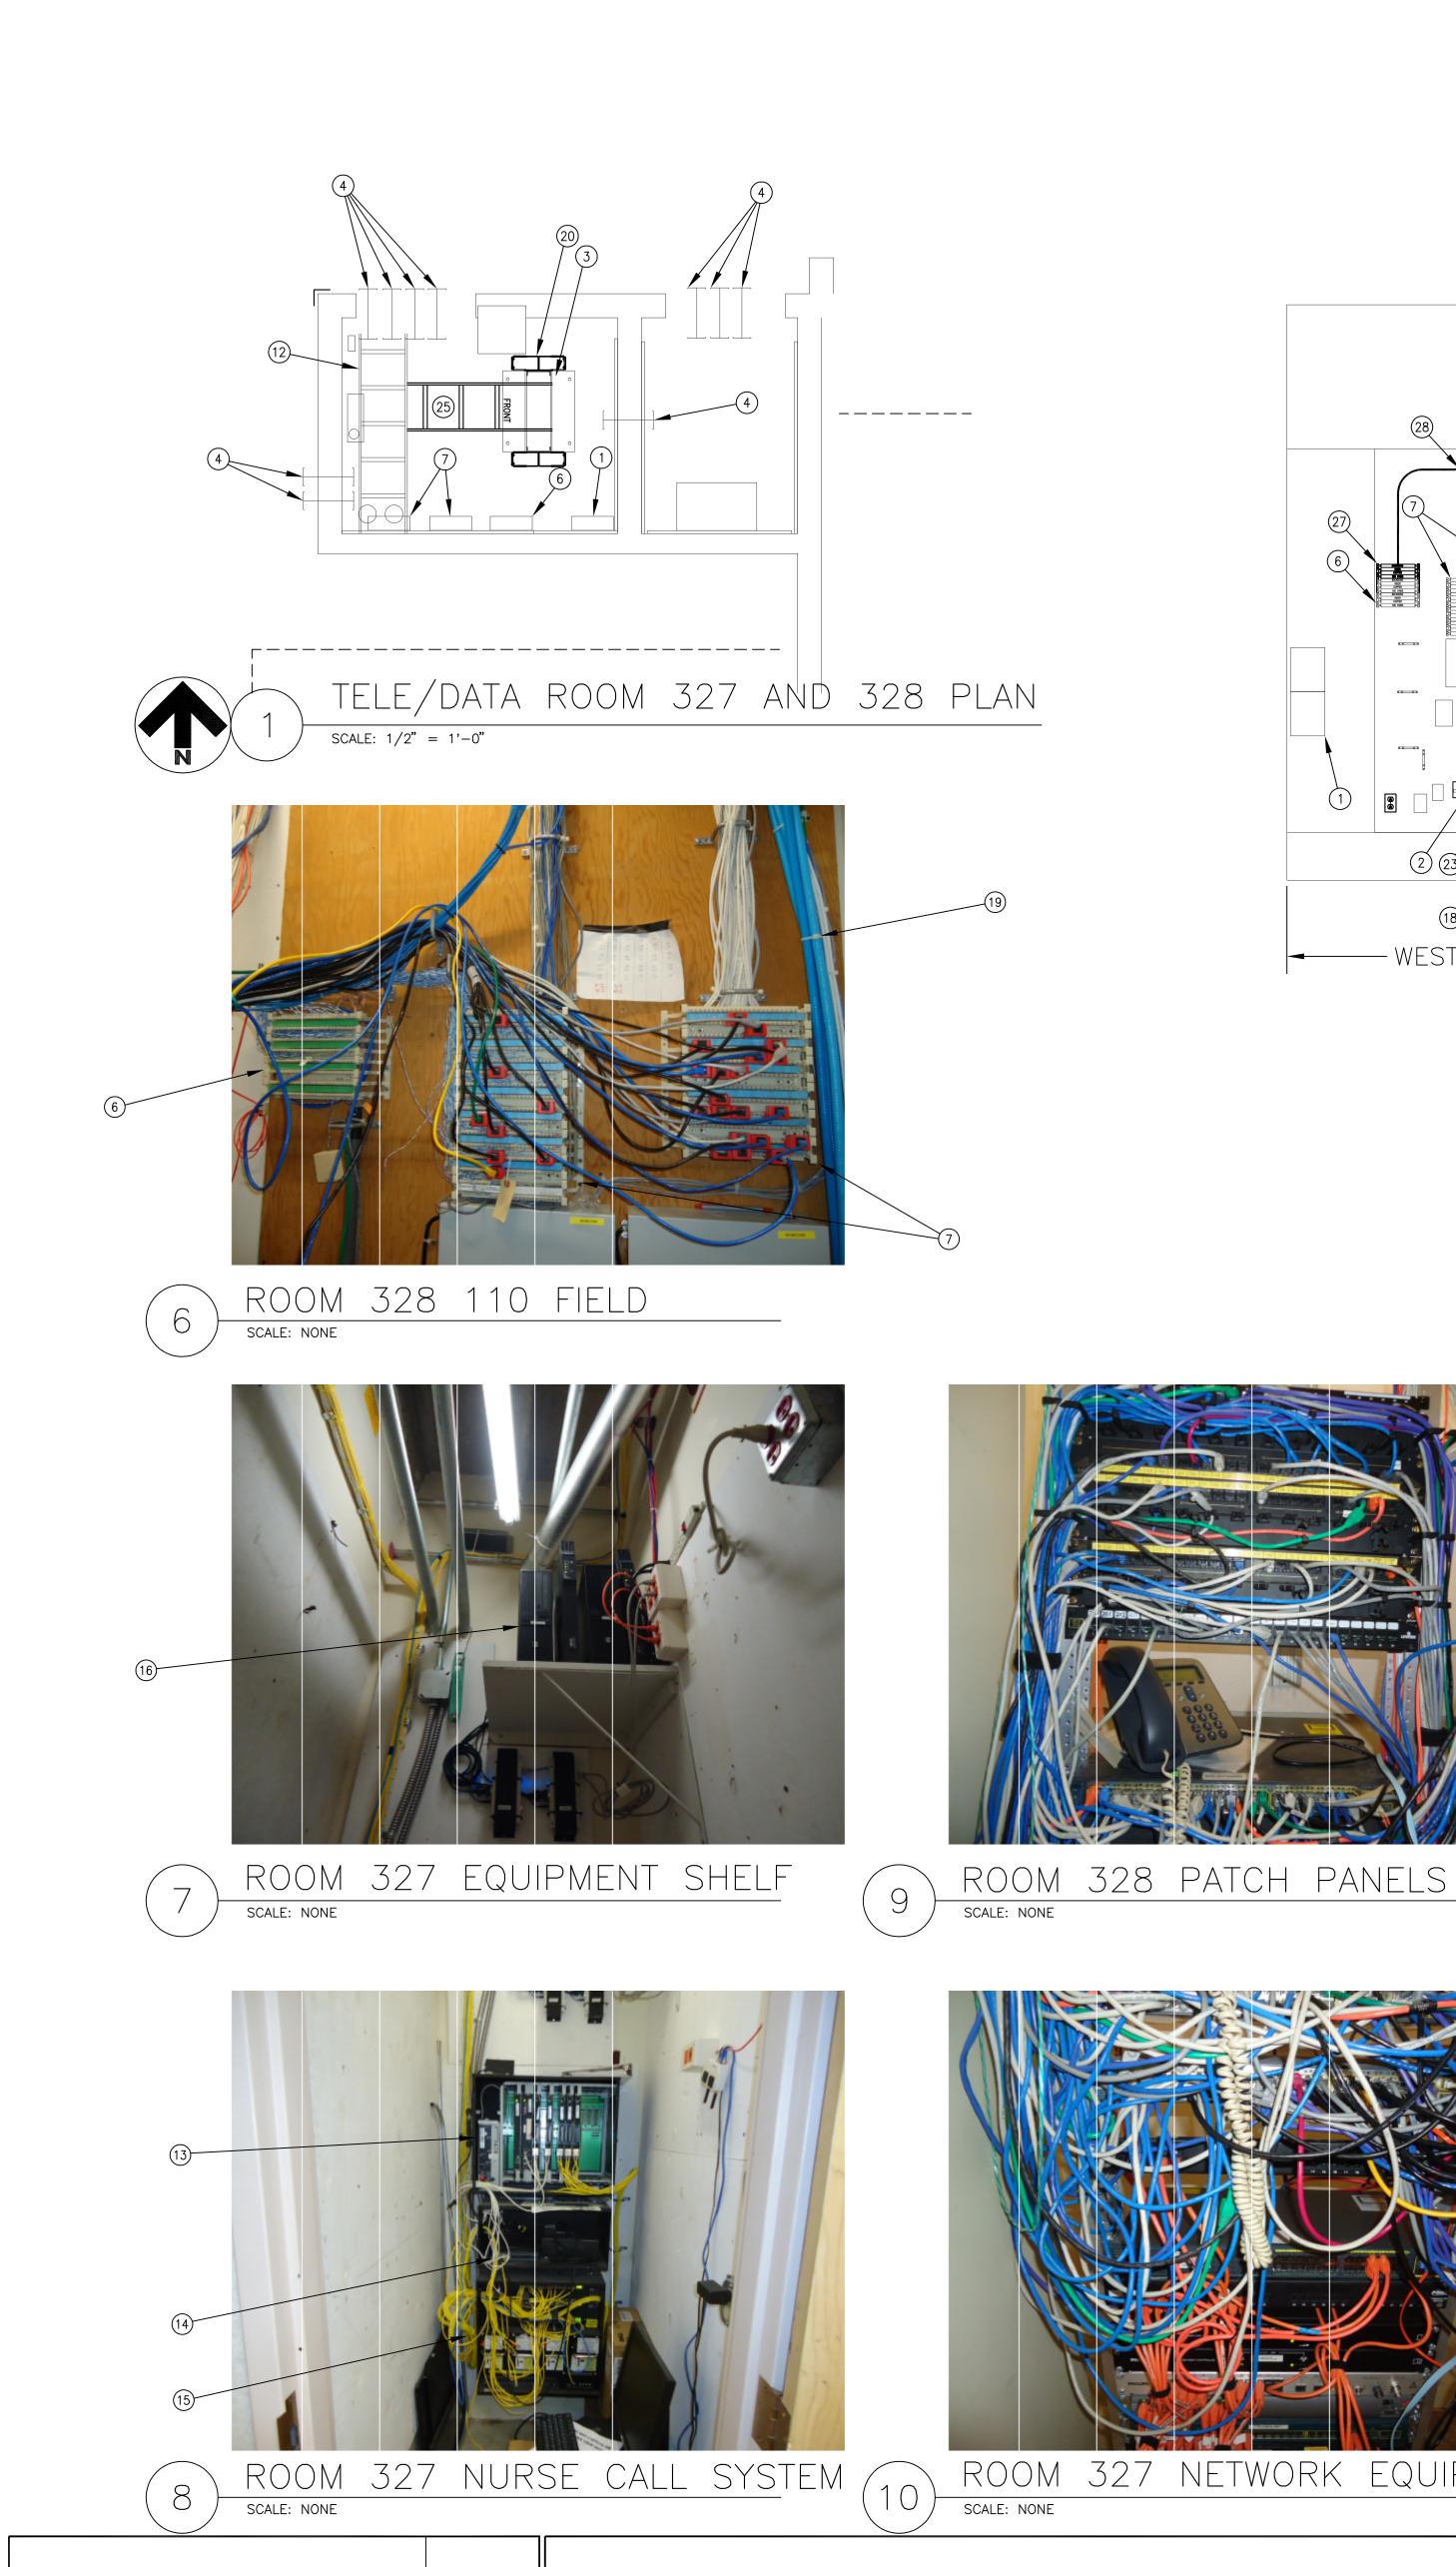PANDUIT 48-PORT

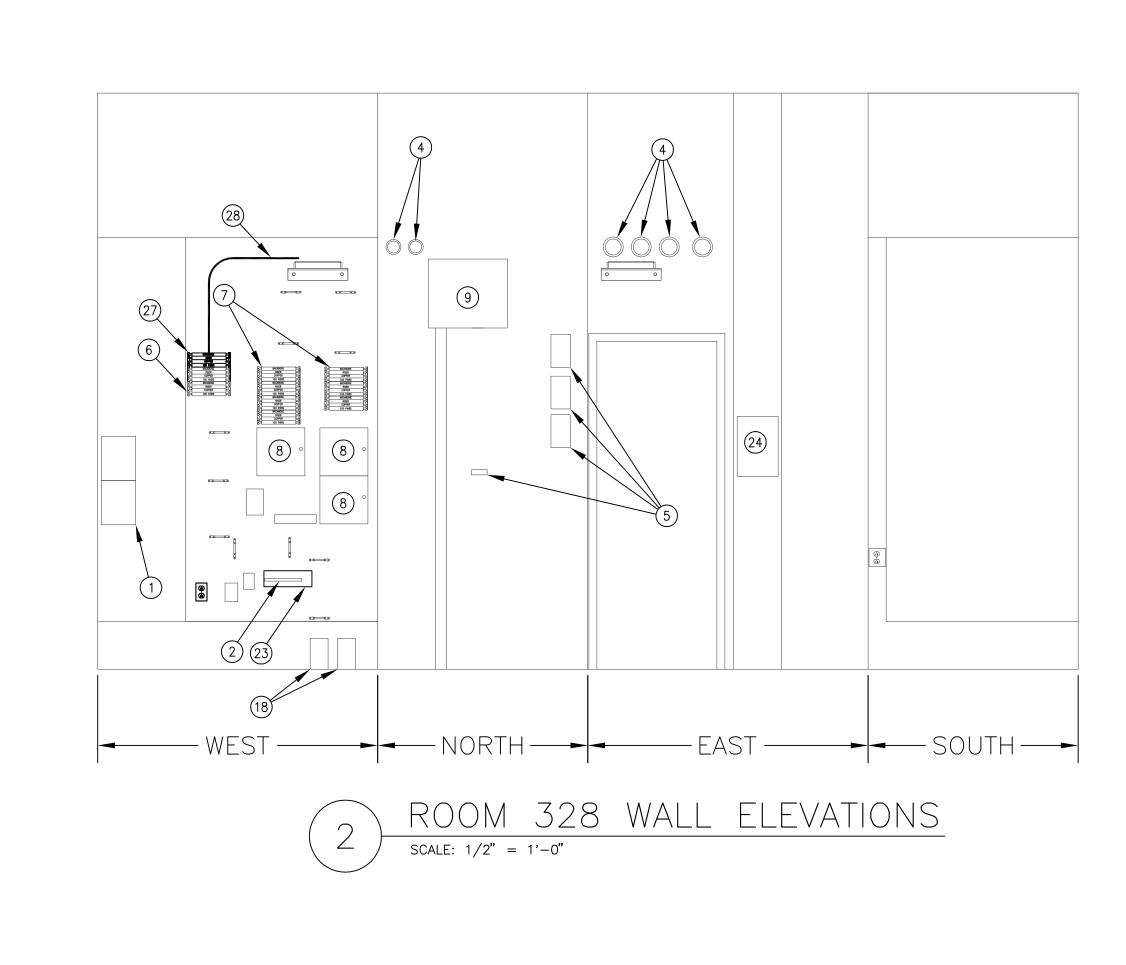CATSE PATCH PANEL 1RU MANAGER HOMOCO 48-PORT

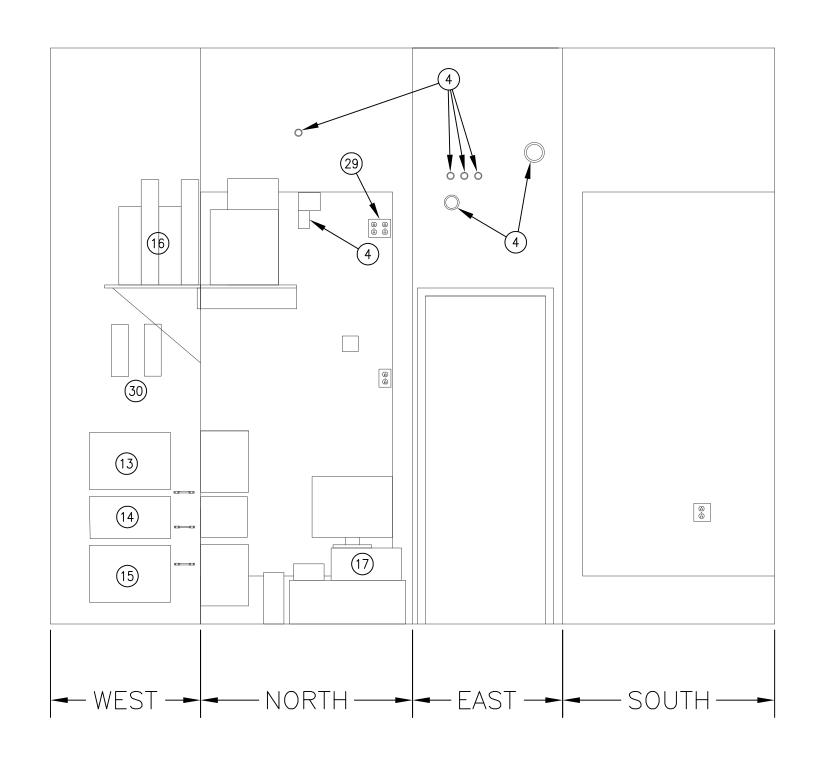CAT5 PATCH PANEL | |

CAT5 PATCH PANEL

1RU VACANT CISCO 3750 SWITCH

1RU VACANT UNKNOWN DEVICE

2RU VACANT

48VDC RECTIFIER

EXISTING

EQUIPMENT RACK 1

SCALE: 1'' = 1'-0''

ROOM 328 RACK ELEVATION

1RU MANAGER

EQUIPMENT RACKS ROOM 327 RACK ELEVATION SCALE: 1'' = 1'-0''

#### GENERAL NOTES:

- A. TERMINATE ALL CABLES FROM ALL FLOORS IN THIS TELECOMMUNICATIONS ROOM.
- B. FIRESTOP WALL PENETRATIONS AND CONDUIT SLEEVE ENDS AFTER INSTALLATION OF CABLES.
- C. COORDINATE WITH ARCHITECTURAL, MECHANICAL, ELECTRICAL, AND FIRE SAFETY WORK TO AVOID CONFLICTS. DO NOT BEGIN INSTALLATION OF TELECOMMUNICATIONS HARDWARE UNTIL DOOR IS INSTALLED AND SPACE IS PAINTED.
- D. REFER TO SHEET E3.1-3 FOR BONDING AND GROUNDING REQUIREMENTS OF TMGB AND TGB.
- E. REMOVE PATH PANELS VACATED BY DEMOLITION PHASE.
- F. REMOVE HORIZONTAL MANAGERS ADJACENT TO EXISTING PATCH PANELS VACATED BY DEMOLITION PHASE.
- G. EXISTING NURSE CALL SYSTEM MAY REPLACED BY THE TIME THIS PROJECT IS IN THE CONSTRUCTION PHASE.

#### # SHEET NOTES:


- 1. (E) WALL MOUNTED OPTICAL FIBER ENCLOSURE.
- 2. (E) GROUNDING BUSBAR. 3. (E) EQUIPMENT RACK. MOVE TO ACCOMMODATE NEW VERTICAL MANAGERS AND FASTEN TO CONCRETE FLOOR.
- 4. (E) CONDUIT SLEEVES WITH FIRESTOPPING PUTTY.
- 5. (E) CATV 8-PORT TAP.
- 6. (E) 200-PIAR, CAT-3 BACKBONE CABLE TERMINATION ON 110 BLOCKS, 901-1100.
- 7. (E) CAT-5 HORIZONTAL CABLE TERMINATIONS ON 110 BLOCKS.
- RÉMOVE ABANDONED CABLES, JUMPER WIRES AND PATCH CABLES.
- 8. (E) WALL-MOUNTED SECURITY PANEL. 9. (E) JUNCTION BOX.
- 10. (E) PATCH PANELS. RETIRE IF VACATED BY DEMOLITION PHASE. RETURN PATCH CABLES TO OWNER. 11. (E) NETWORK SWITCHES.
- 12. (E) CABLE TRAY TO BE EXPANDED. PROVIDE 6" BOLT ON LEGS.
- 13. (E) UPPER CABINET WITH COMDIAL PHONE SYSTEM.
- 14. (E) MIDDLE CABINET WITH NURSE CALL SYSTEM MISCELLANEOUS
- ÈQUIPMENT. REFER TO GENERAL NOTE G ON THIS SHEET.
- 15. (E) LOWER CABINET WITH NURSE CALL POWER SUPPLIES. 16. (E) NURSE CALL SYSTEM SERVERS AND UPS UNITS ON OVERHEAD
- 17. (E) NURSE CALL SYSTEM ADMINISTRATION PC AND UPS.
- 18. (E) SLEEVES TO FLOOR BELOW. 19. (E) CLEARWIRE ANTENNA CABLES, DO NOT INTERRUPT SERVICE
- OUTSIDE PROJECT CONSTRUCTION PHASE BOUNDARY.
- 20. (N) TWO DOUBLE SIDED VERTICAL CABLE MANAGERS (CPI 13911-703 OR EQUAL), 3.9"W X 16.4"D X 7'H. DRESS EXISTING AND NEW HORIZONTAL CABLE IN BACK AND PATCH CORDS IN
- 21. (N) TWO, CAT-6, 48-PORT ANGLED PATCH PANELS IN VACANT MOUNTING SPACES. TERMINATE, TEST AND LABEL NEW HORIZONTAL
- 22. (N) RACK MOUNTED GROUNDING BUSBAR. BOND TO NEW WALL MOUNTED GROUND BAR. RE:3.1-3.
- BONDING CONDUCTORS ON 2-HOLE LUGS AND TRANSFER TO NEW BUSBAR. PROVIDE NEW BONDING CONDUCTORS. RE:E3.1-3.

23. (N) ISOLATED GROUND BAR ON WALL. TERMINATE EXISTING

- 24. (E) CISCO IP PHONE. RELOCATE TO WALL MOUNT BRACKET. 25. (N) SECTION OF LADDER STYLE CABLE TRAY TO EQUIPMENT RACK.
- CONNECT TO EXISTING TRAY AND BOND TO TGB. 26. (N) CAT-3 PATCH PANEL FOR 25-PAIR CABLE AND 24, RJ45 JACKS WITH 1 ACTIVE PAIR ON PINS 4&5. TERMINATE PAIRS 24
- AND 25 ON LAST JACK. 27. (N) 110 WIRING BLOCK WITH LEGS AND C5 CONNECTOR BLOCKS.
- TERMINATE 25-PAIR UTP CAT 3 CABLE TO NEW PATCH PANEL ON EQUIPMENT RACK. LABEL AND TEST THE INSTALLATION.
- 28. (N) 25-PAIR, 24 AWG UTP CABLE FROM 110 WIRING BLOCK TO NÉW PATCH PANEL. ROUTE TO EQUIPMENT RACK OVER EXISTING AND NEW CABLE TRAY. OWNER TO PROVIDE JUMPERS AND PATCH CORDS TO ACTIVATE VOICE GRADE CIRCUITS AS NEEDED.
- 29. (E) OUTLETS SERVING NURSE CALL SYSTEM. 30. (E) REMOTE ACCESS KVM SWITCHES.

EXISTING

JAY ROMLEIN, RCDD C.W. MOORE PLAZA 250 S. 5TH ST BOISE, IDAHO PHONE: 208-343-4635 FAX: 208-343-1858 THESE DRAWINGS AND SPECIFICATIONS, AS INSTRUMENTS OF SERVICE, ARE AND SHALL REMAIN THE PROPERTY OF THE ARCHITECT / ENGINEER WHETHER THE PROJECT FOR C.W. MOORE PLAZA WHICH THEY ARE MADE IS EXECUTED OR NOT. THESE DRAWINGS AND SPECIFICATIONS SHALL NOT BE USED BY 250 S. 5TH ST. BOISE, ID 83702 ANY PERSON OR ENTITY ON OTHER PROJECTS, FOR ADDITIONS TO THIS PROJECT, OR COMPLETION OF THIS (208) 343-4635 FAX (208) 343-1858

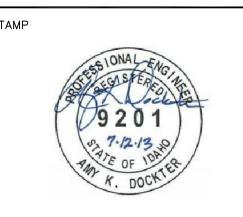

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BOISE VAMC DRAWING TITLE THIRD FLOOR BUILDING 67 EXPANSION TELECOMMUNICATION ROOM DETAILS BUILDING NUMBER APPROVED: CHIEF OF FACILITY MANAGEMENT SERVICE CHECKED

APPROVED: MEDICAL CENTER DIRECTOR

PROJECT NO. 531-320 DRAWING NO. JDR VAMC BOISE, IDAHO

DWG 178 OF 191

JDR

